SHEET LIST - MECHANICAL

Sheet Number Sheet Name

LEVEL 1 - THERMAL ZONING M101 M102 LEVEL 2 - THERMAL ZONING M201 LEVEL 1 - HVAC PLAN M202 LEVEL 2 - HVAC PLAN M203 ROOF - HVAC PLAN M601 RISER DIAGRAMS M901 MECHANICAL DETAILS M902 MECHANICAL DETAILS M903 MECHANICAL DETAILS MEP 000 MEP COVER SHEET

SHEET LIST - ELECTRICAL

Sheet Number Sheet Name

E101	ELECTRICAL SITE PLAN
E301	LEVEL 1 - POWER AND SIGNAL PLAN
E501	ELECTRICAL SINGLE LINE DIAGRAM
E505	SIGNAL SINGLE LINE DIAGRAM
E601	ENLARGED PLANS


SHEET LIST - PLUMBING

MEP 000

Sheet Number Sheet Name

P001	BASIS OF DESIGN
P002	SCHEDULES
P200	UNDERGROUND PLAN - PLUMBIING
P201	LEVEL 1 - FLOOR PLAN
P202	LEVEL 2 - FLOOR PLAN
P203	ROOF - FLOOR PLAN
P401	PLUMBING WATER RISER DIAGRAMS
P402	PLUMBING SANITARY RISER DIAGRAMS
P403	PLUMBING STORM RISER DIAGRAMS
P601	ENLARGED PLANS
P901	PLUMBING DETAILS

UO OREGON BACH FESTIVAL MEP COVER SHEET

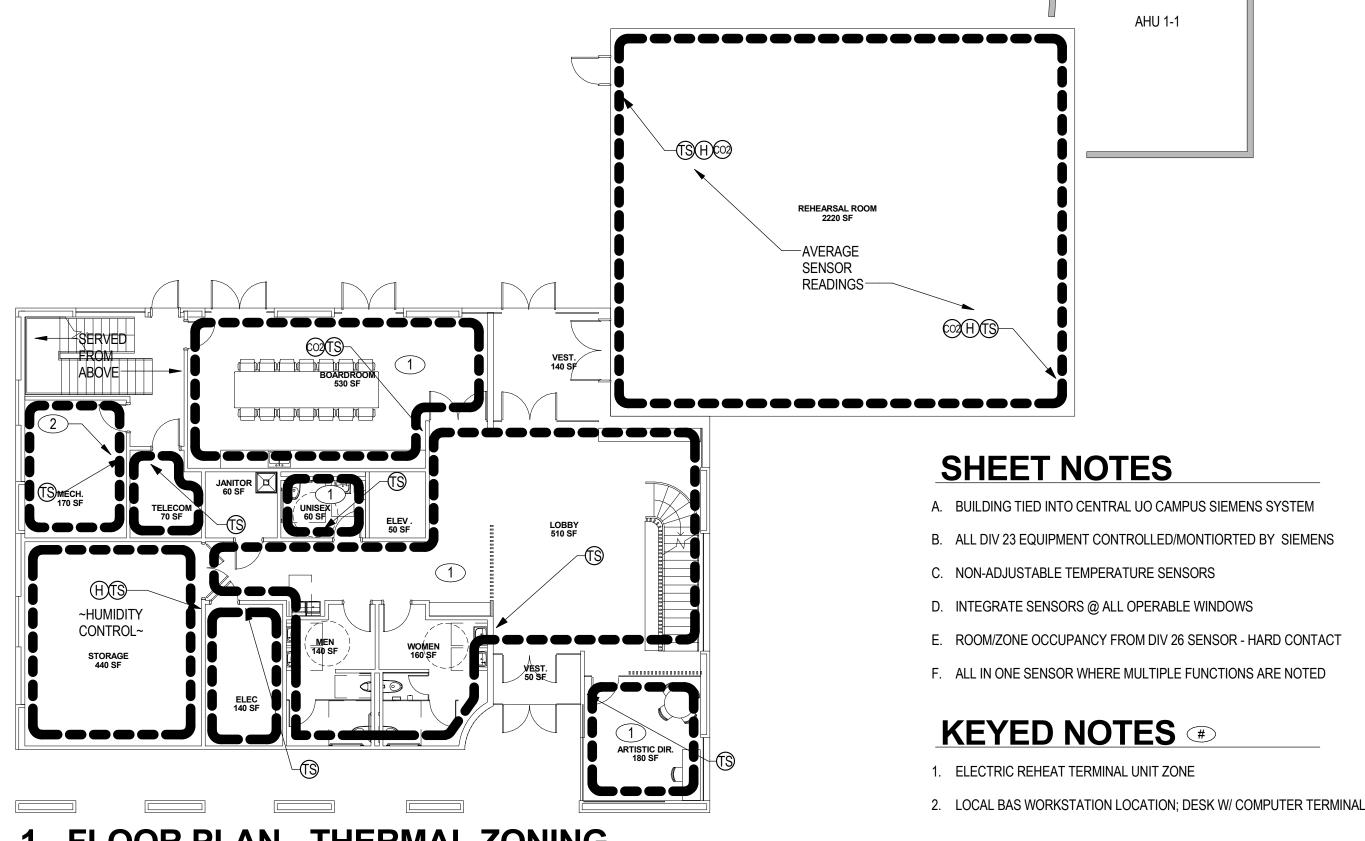


LEVEL 1 - FLOOR PLAN - THERMAL ZONING

SCALE: 3/32" = 1'-0"

UO OREGON BACH FESTIVAL

LEVEL 1 - THERMAL ZONING

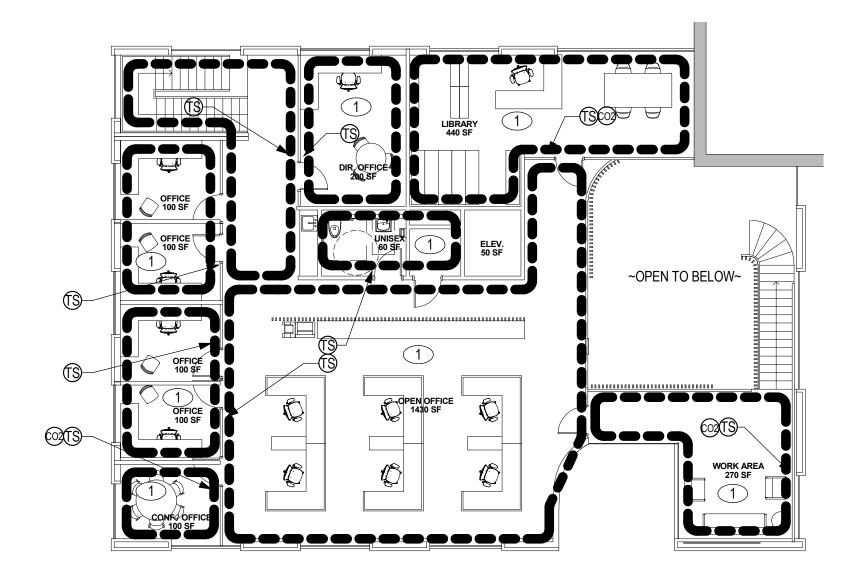


1 LEVEL 2 - FLOOR PLAN - THERMAL ZONING SCALE: 3/32" = 1'-0"


SHEET NOTES

- A. BUILDING TIED INTO CENTRAL UO CAMPUS SIEMENS SYSTEM
- B. ALL DIV 23 EQUIPMENT CONTROLLED/MONTIORTED BY SIEMENS
- C. NON-ADJUSTABLE TEMPERATURE SENSORS
- D. INTEGRATE SENSORS @ ALL OPERABLE WINDOWS
- E. ROOM/ZONE OCCUPANCY FROM DIV 26 SENSOR HARD CONTACT
- F. ALL IN ONE SENSOR WHERE MULTIPLE FUNCTIONS ARE NOTED

UO OREGON BACH FESTIVAL LEVEL 2 - THERMAL ZONING

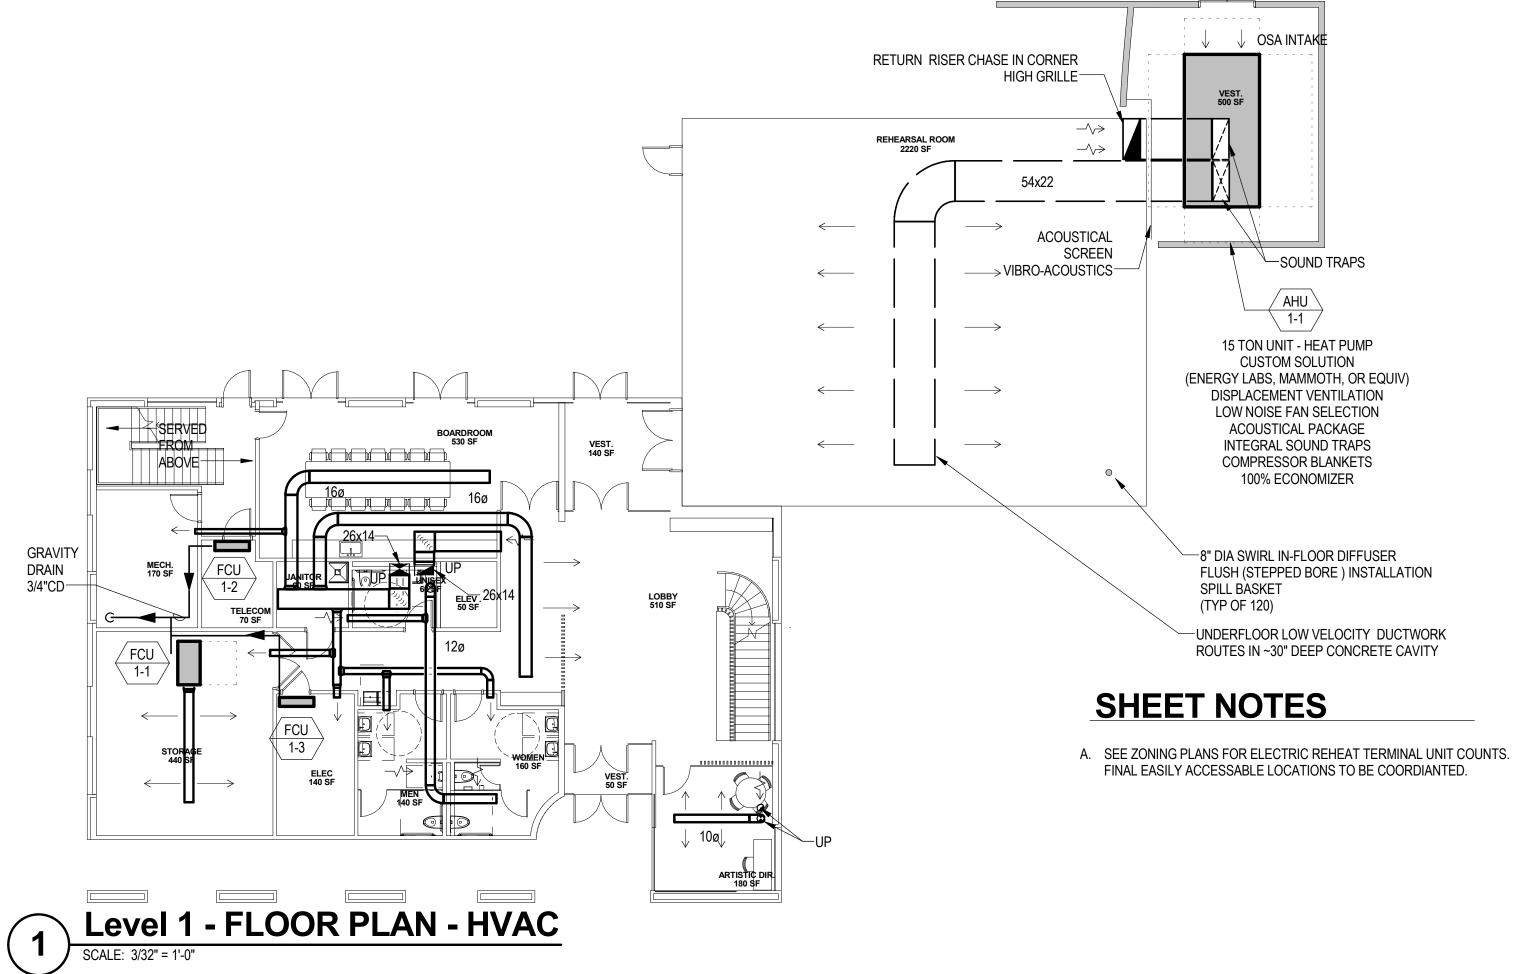

LEVEL 1 - HVAC PLAN

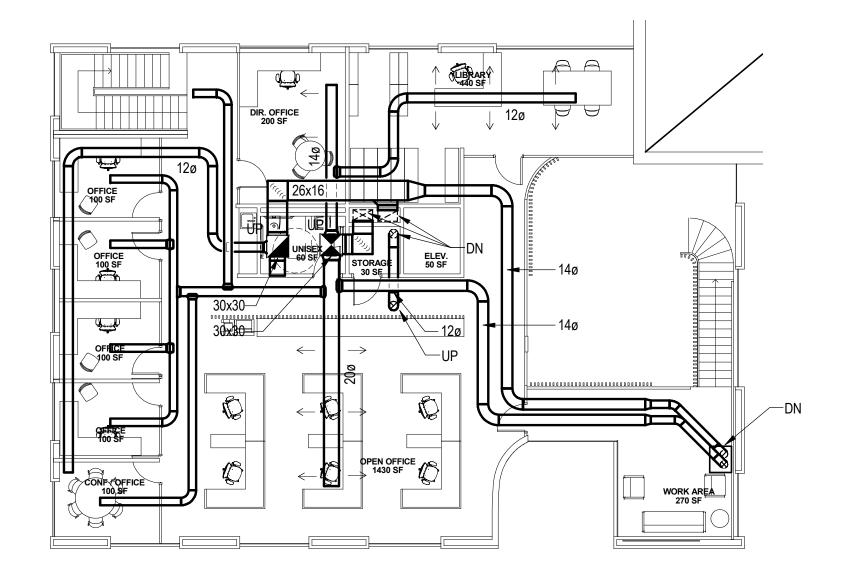

1 Level 2 - FLOOR PLAN - HVAC SCALE: 3/32" = 1'-0"


SHEET NOTES

- A. SEE ZONING PLANS FOR ELECTRIC REHEAT TERMINAL UNIT COUNTS. FINAL EASILY ACCESSABLE LOCATIONS TO BE COORDIANTED.
- B. NO FIBERGLASS ACOUSTICAL LINER
- C. PROVIDE BALANCE DAMPERS ON ALL SUPPLY, RETURN & EXHAUST BRANCHES
- D. PROVIDE 2' MINIMUM STRAIGHT DUCT BEFORE CONNECTION WITH VAV NECK


M202

UO OREGON BACH FESTIVAL LEVEL 2 - HVAC PLAN

HACKER

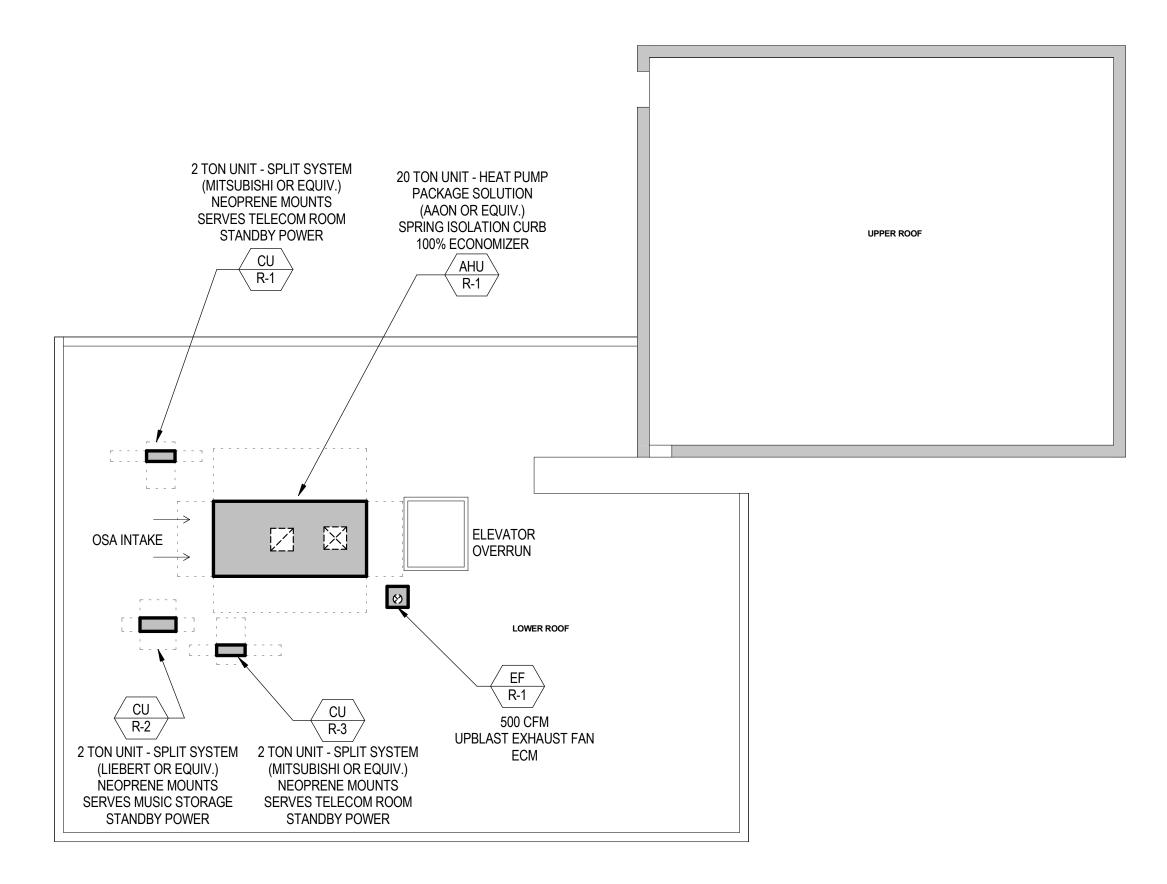




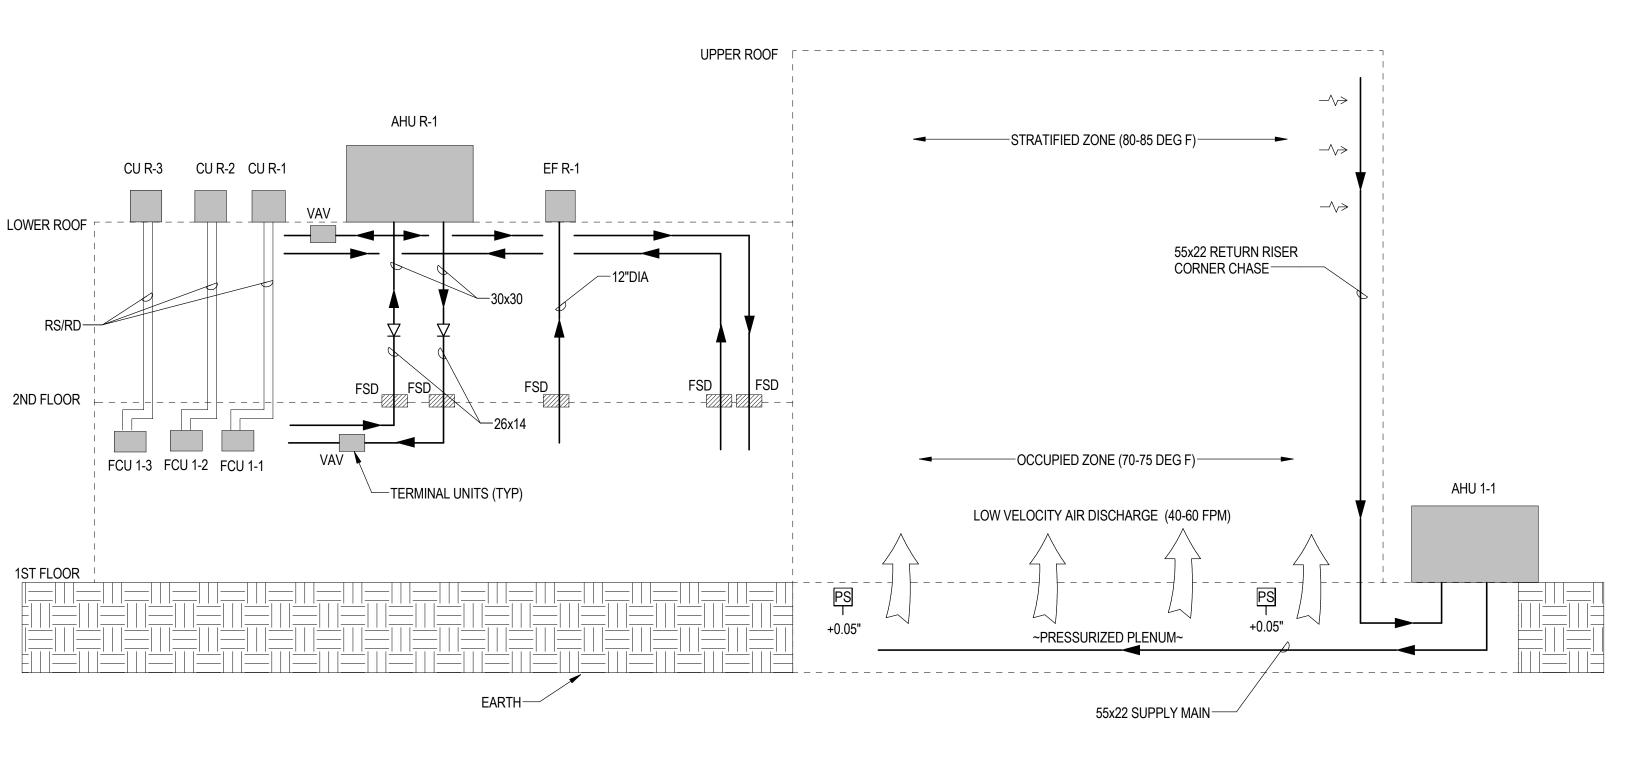




RISER DIAGRAMS

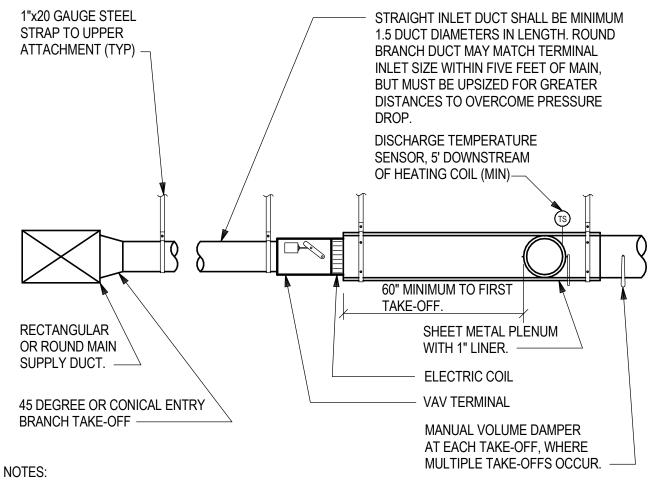

1. SHEET METAL OUTLET PLENUM SHALL BE LINED WITH 1" THICK INSULATION WITH FIBER-FREE LINER. INSIDE CLEAR DIMENSIONS SHALL BE 2" HIGHER THAN UNIT HEIGHT AND 4" WIDER THAN UNIT WIDTH.

NOTES: (ADD TO NOTES ABOVE AS APPLICABLE.)

- 2. FOR ACUTE CARE FACILITIES AND SURGERY CENTERS: THE INSIDE SURFACE OF THE DISCHARGE PLENUM SHALL INCLUDE 24 GAUGE SHEET METAL FOR A CLEANABLE SURFACE.
- 3. HEATING WATER COIL MUST BE 2-ROW MINIMUM FOR IMPROVED TEMPERATURE CONTROL AND INCREASED LIFE.

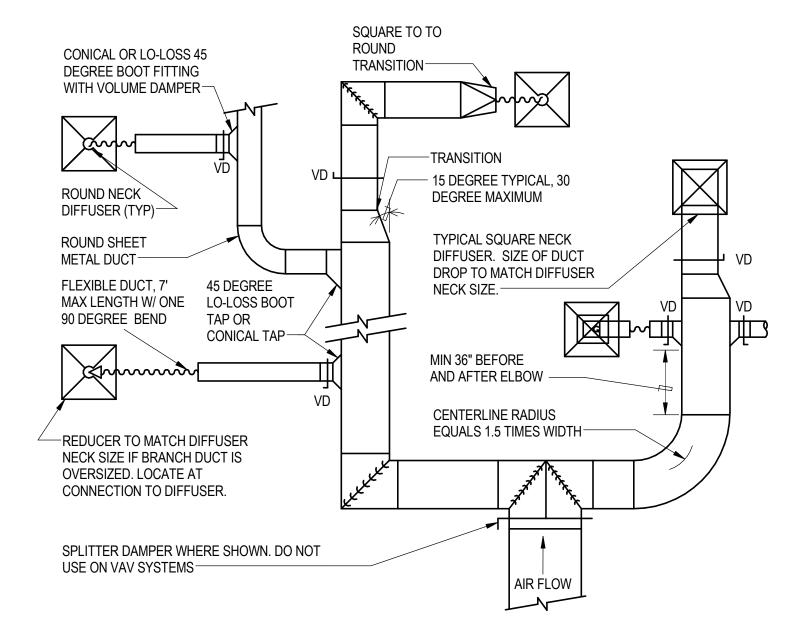

NOTES:

- PROVIDE DUCT LINER AND/OR EXTERNAL DUCT INSULATION AS NOTED ON PLANS OR IN SPECIFICATIONS.
- PROVIDE HANGERS AND SEISMIC BRACING PER SMACNA AND BUILDING CODE REQUIREMENTS.
- 3. LOCATE MANUAL BALANCING DAMPERS IMMEDIATELY DOWNSTREAM OF EACH DUCT TAP.
- 4. CUSHION HEADS OR BULLHEAD TEES ARE NOT ALLOWED.
- MAINTAIN MINIMUM 36" CLEARANCE BETWEEN LEADING OR TRAILING ELBOW JOINT AND DUCT TAP FITTINGS.
- 6. RADIUSED ELBOWS OR TURNING VANES REQUIRED ON RECTANGULAR DUCT SYSTEM ELBOWS. SINGLE THICKNESS VANES UP TO 25" HEIGHT AND DOUBLE THICKNESS VANES IN DUCTS GREATER THAN 25" HEIGHT.






UO OREGON BACH FESTIVAL

MECHANICAL DETAILS

HACKER

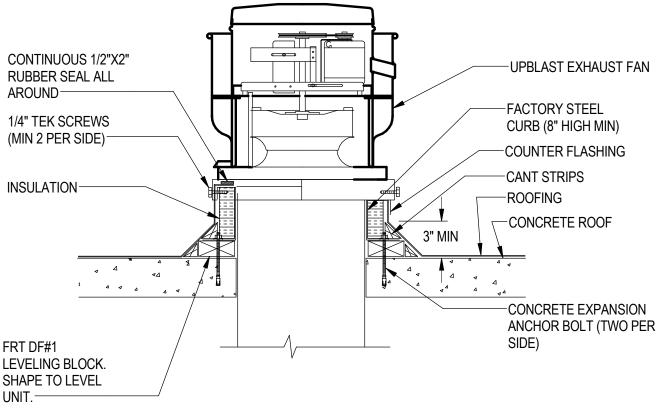

NOTES:

1. COORDINATE ANCHORAGE REQUIREMENTS WITH STRUCTURAL DESIGN.

UPBLAST EXHAUST FAN SCALE: NONE

NOTES: (#)

DAMPER BLADES

OPEN AND CLOSED POSITIONS.

CONNECTIONS ARE SHOWN.

OPENING.

FSD FLOOR AIRFOIL BLADE

ON THE WALL DAMPER ACCESS PANEL. ATTACH WITH EPOXY ADHESIVE.

12. REFER TO SPECIFICATION SECTION 233113 FOR ADDITIONAL REQUIREMENTS.

(9)

(10)

INSTALLATION INSTRUCTIONS. MINIMUM 1" ANGLE OVERLAP ON ALL SIDES OF PARTITION WALL.

DAMPER SLEEVE ON OPPOSITE SIDE OF WALL FROM ACTUATOR MUST BE MINIMUM 3" AND MAXIMUM OF 6" LONG. DUCT CONNECTION AS PERMITTED AS A CONDITION OF DAMPER LISTING. FLANGED BREAK-AWAY STYLE DUCT/SLEEVE

DESIGN FOR POWER. CONTROL WIRING AND SEQUENCE OF OPERATION.

SCALE: NONE

UO OREGON BACH FESTIVAL

OREGON BACH FESTIVAL February 5, 2016

DUCT

DUCT

ELECTRIC ACTUATOR MOTOR INTERLOCKED WITH SMOKE DETECTOR OR FIRE ALARM SYSTEM. COORDINATE WITH ELECTRICAL

ELECTRIC RESETTABLE FUSIBLE LINK CLOSES AND LOCKS THE DAMPER WHEN TEMPERATURE EXCEEDS PRESET TEMPERATURE.

7. ACCESS DOOR SHOWN ON BOTTOM OF SLEEVE FOR ACCESS TO FIRE DAMPER BLADES. PANEL TO BE HINGED WITH AIRTIGHT SEAL.

ACCESS SIZE MUST BE MINIMUM OF 12" BY 12" OR THE WIDTH OF DUCT IF SMALLER THAN 12" WIDE. ACCESS PANEL MUST BE

DUCT SMOKE DETECTOR MOUNTED ON DUCT SLEEVE OPPOSITE ACTUATOR WITHIN FIVE FEET OF DAMPER. OR. AREA SMOKE

LOCATE 3/4" HIGH WHITE PLASTIC LAMINATE SIGNS WITH 3/8" HIGH BLACK LETTERING WITH THE INITIALS "FSD" AND UNIQUE NUMBER

10. FIRE/SMOKE DAMPER DETAIL FOR REFERENCE ONLY. FIRE DAMPERS SHALL BE STATE FIRE MARSHAL APPROVED. INSTALL PER MANUFACTURER'S PRINTED INSTALLATION INSTRUCTIONS WHICH SHALL BE MADE AVAILABLE TO INSPECTION AUTHORITIES. 11. UL 555 & 555S COMPLIANT. LISTINGS: RUSKIN#R5531, GREENHECK#R13317, POTTORFF#R11767, NAILOR#R9492, CESCO#R6462

LABELED WITH THE WORDS. "FIRE DOOR - DO NOT OBSTRUCT" IN LETTERS NO LESS THAN 1" IN HEIGHT. EXTERNAL INSULATION

SHALL NOT CONCEAL ACCESS UNLESS A LABEL IS ATTACHED TO THE INSULATION WHICH INDICATES THE EXACT LOCATION OF THE

DETECTORS CONNECTED TO CENTRAL FIRE ALARM SYSTEM. SMOKE DETECTORS SHALL BE ADDRESSABLE AND UNIQUELY TAGGED

DAMPER MAY BE RESET BY PRESSING RESET BUTTON. INTEGRAL DAMPER BLADE INDICATOR SWITCH FOR REMOTE MONITORING OF

STEEL RETAINING ANGLES, MINIMUM 1-1/2"x1-1/2"x0.060", FASTENED TO FIRE DAMPER SLEEVE. ANGLES SHALL BE INSTALLED ON ALL

FOUR SIDES OF DAMPER AND ON EACH SIDE OF THE WALL. FASTEN ANGLE TO SLEEVE WITH #10 SHEET METAL SCREWS (MINIMUM).

ANGLE GAGE AND FASTENING METHOD AS PERMITTED AS A CONDITION OF DAMPER LISTING. REFER TO MANUFACTURER'S WRITTEN

Ó


SLEEVE-


RATED FLOOR

FRT DF#1 LEVELING BLOCK. SHAPE TO LEVEL UNIT.

MECHANICAL DETAILS

M902

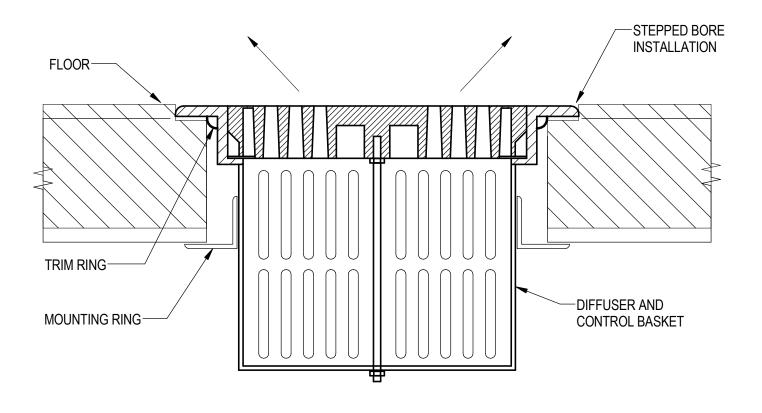

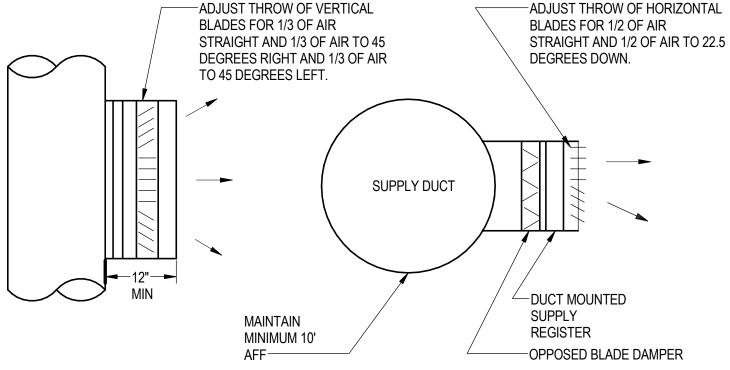

NOTES:

- 1. NON-ROOM SIDE ADJUSTABLE, DAMPER ACCESSED VIA DIFFUSER FACE REMOVAL.
- 2. STEPPED BORE INSTALLATION FOR FLUSH INSTILLATION WITH FLOOR. COORDINATE WITH GC.

NOTES:

1. ADJUST INITIAL AIR FLOW DIRECTIONS AS SHOWN. FINAL AIR BALANCE SHALL ADJUST FLOW DIRECTIONS TO REDUCE AIR VELOCITIES IN OCCUPIED SPACE TO 50 FPM (MAXIMUM).

UFAD DIFFUSER SCALE: 1/8" = 1'-0"



EXPOSED DUCT SUPPLY REGISTER

SCALE: 1/8" = 1'-0"

UO OREGON BACH FESTIVAL

MECHANICAL DETAILS

OREGON BACH FESTIVAL **HACKER** February 5, 2016

M903


KEYED NOTES # 1 PROVIDE (1) 4" CONDUITS (SPARE) AND (1) 4" CONDUITS WITH (3) #2 MV-105 15KV CABLES PER SERVICE. -ELECTRICAL POINT (E) UTILITY TUNNEL-OF CONNECTION IN TUNNEL -PROPOSED VAULT ACCESS LOCATION (TYPICAL) -(3) 3" CONDUITS UTILITY TRANSFORMERS-000000 50' - 0" .0 - .69 (1) 3" CONDUITS--ELECTRICAL ROOM 140 SEE 2/E6.01

90' - 0"

1 ELECTRICAL SITE PLAN
SCALE: 1" = 40'-0"


UO OREGON BACH FESTIVAL


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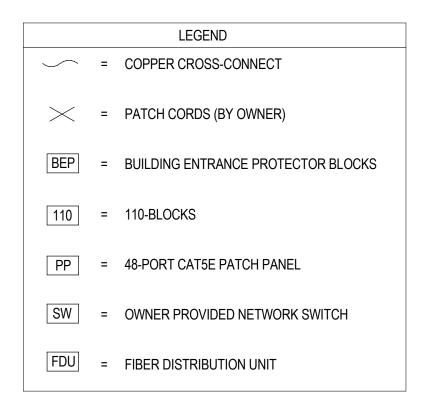


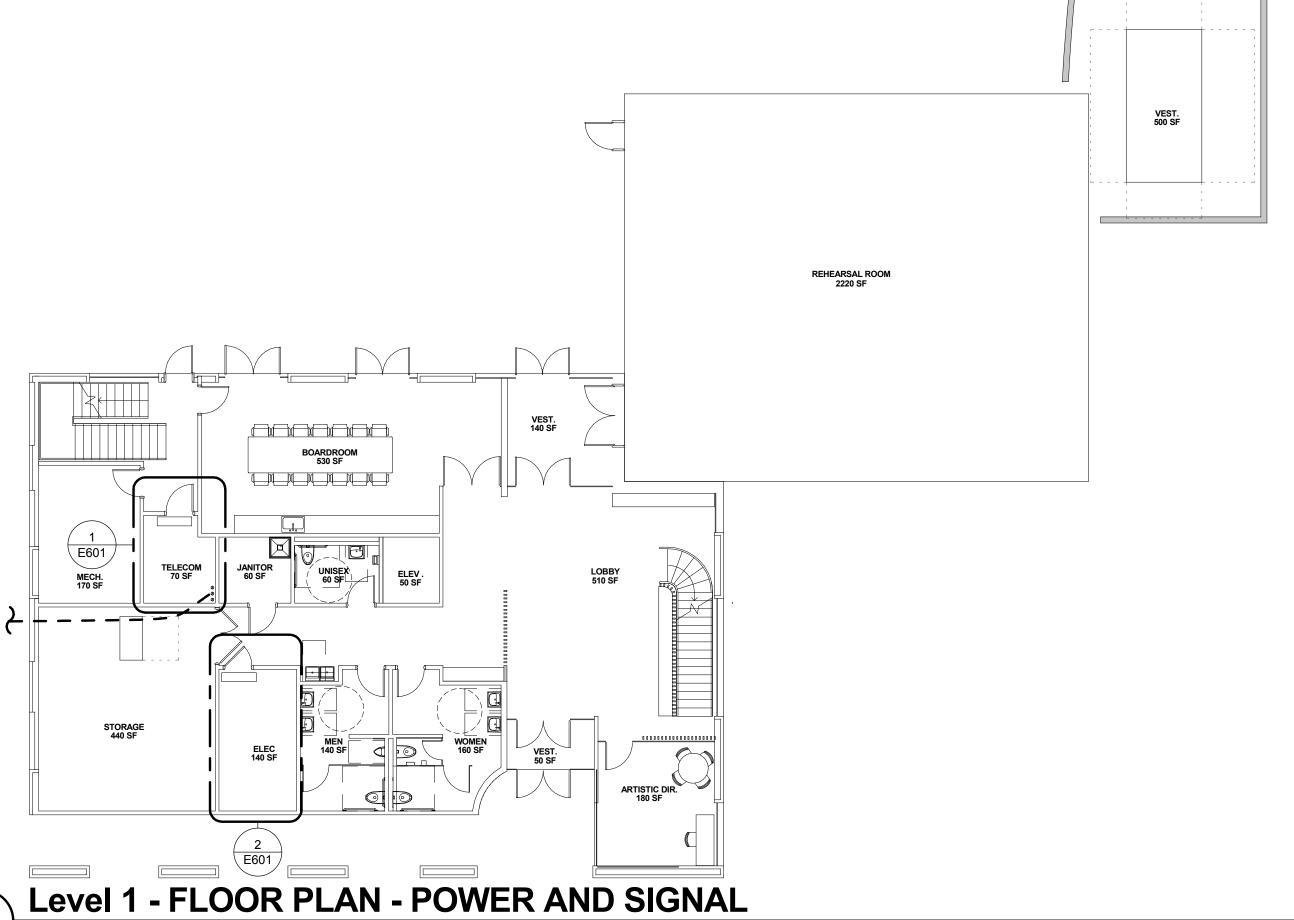SCALE: 3/32" = 1'-0"

UO OREGON BACH FESTIVAL




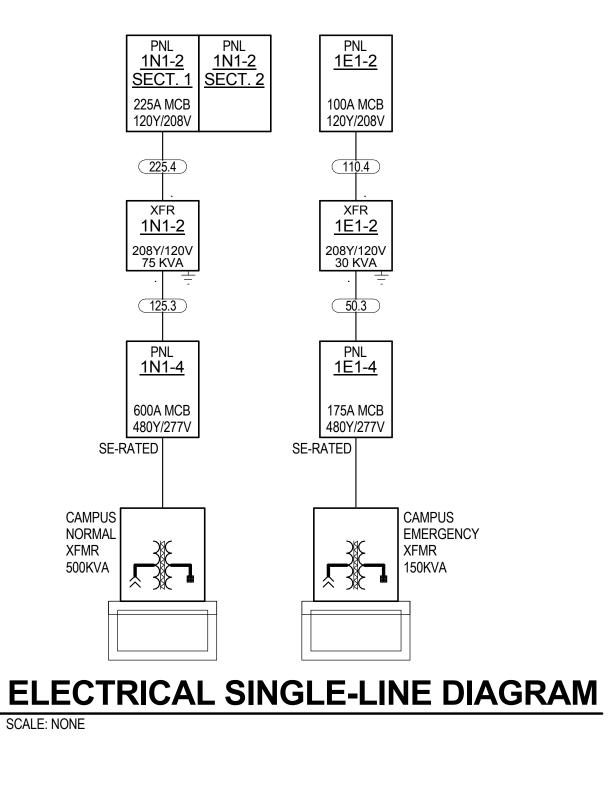


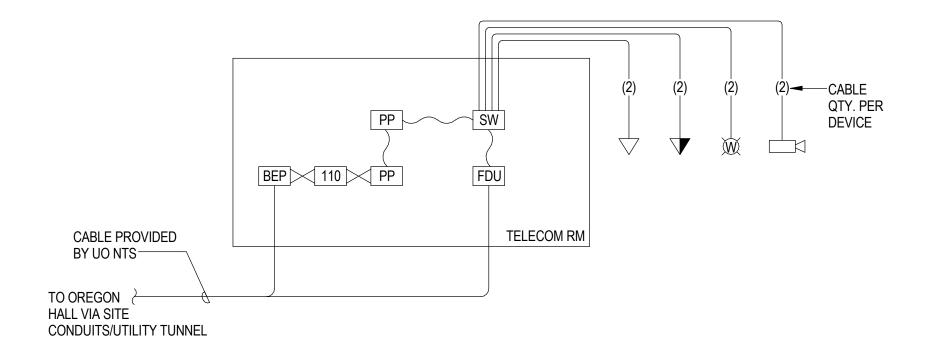



HACKER

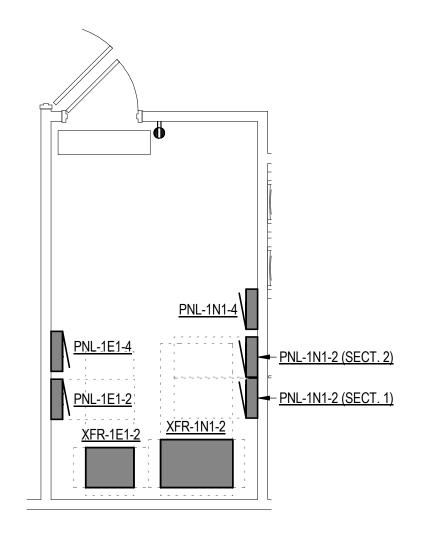

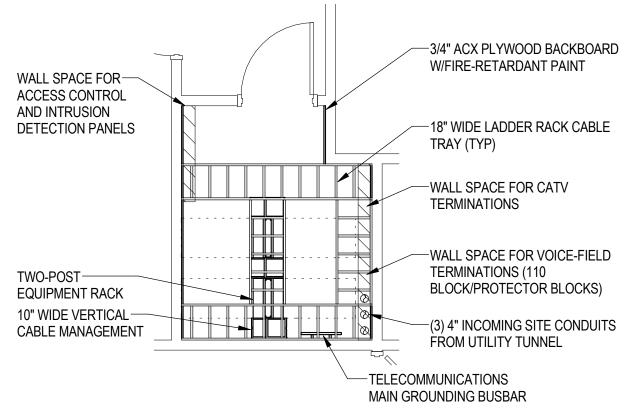





PLUMBING BASIS OF DESIGN

- 1.1 PLUMBING BASIS OF DESIGN
- A. THIS BUILDING IS A NEW TWO-STORY CONCERT HALL AND OFFICE SPACE.
- B. THE DESIGN INCLUDES THE FOLLOWING NOTABLE FEATURES, BUT IS NOT LIMITED TO THIS SCOPE. CONTRACTOR IS RESPONSIBLE FOR REVIEWING ALL CONTRACT DOCUMENTS AND COORDINATING WITH ALL DISCIPLINES.
- C. CODES AND STANDARDS
 - 1. AMERICANS WITH DISABILITIES ACT (ADA)
 - 2. NFPA 99: HEALTH CARE FACILITIES CODE, 2012 EDITION
 - 3. OREGON BUILDING CODES ENFORCED BY THE AUTHORITY HAVING JURISDICTION (AHJ):
 - a) 2010 OREGON STRUCTURAL SPECIALTY CODE (OSSC) (BASED ON THE 2009 INTERNATIONAL BUILDING CODE WITH STATE AMENDMENTS).
 - b) 2011 OREGON PLUMBING SPECIALTY CODE (OPSC) (BASED ON THE 2009 UNIFORM PLUMBING CODE WITH STATE AMENDMENTS).
 - c) 2010 OREGON MECHANICAL SPECIALTY CODE (OMSC) BASED ON THE 2009 INTERNATIONAL MECHANICAL CODE AND THE 2009 INTERNATIONAL FUEL GAS CODE (IMC).
- D. WATER SUPPLY
 - 1. MINIMUM AVAILABLE WATER PRESSURE (STATIC): _____ PSI AVAILABLE FROM MUNICIPAL WATER SERVICE
 - 2. COLD WATER PIPE SIZE: 2" INCHES
 - 3. COLD WATER METER SIZE: 1 1/2" INCHES
 - 4. COLD WATER DEMAND: 48 GPM (DESIGN TOTAL)
 - 5. COLD WATER AVAILEBLE: 130 GPM (FUTURE TOTAL)
 - 6. REFER TO PLUMBING CALCULATIONS AND SCHEDULES FOR FUTHER CRITERIA
- E. DOMESTIC HOT WATER:
 - 1. DOMESTIC HOT WATER SUPPLY TEMPERATURE: 120°F
 - 2. DOMESTIC HOT WATER RECIRCULATION TEMPERATURE: 90°F. ABOVE THIS TEMPERATURE THE RECIRCULATING PUMP WILL BE OFF.
 - 3. DOMESTIC INCOMING COLD WATER TEMPERATURE: 55°F
 - 4. DOMESTIC HOT WATER HEATER SETPOINT TEMPERATURE: 140°F
- F. SANITARY SEWER:
 - 1. BUILDING SEWER SIZE 4 INCHES AT 2% SLOPE
 - 2. TOTAL CAPACITY 216 DRAINAGE FIXTURE UNITS
 - 3. CONNECTED LOAD 46.5 DRAINAGE FIXTURE UNITS
- G. STORM DRAIN:
 - 1. RAINFALL INTENSITY 1.3 INCHES/HOUR
 - 2. TOTAL SQUARE FOOTAGE: 6160 SQFT
 - 3. PIPE SIZE: 6"

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OREGON BACH FESTIVAL
February 5, 2016

P001

DOMESTIC WATER HEATER SCHEDULE CONNECTION SIZE **ELECTRICAL** VOL **RECOV EWT** LWT **UNIT SIZE** OPER. **NOTES** TAG **MANUFACTURER MODEL NUMBER** LOCATION (GAL) KW VOLTS PH MCA (GPH) (°F) (°F) CW (IN) HW (IN) (L"xW"xH") WT. (LBS) **EWH AO SMITH** SDE-30 MECH ROOM 30 35 55 120 6 408 3 26X26X36 375 1-2

NOTES

- 1. COORDINATE WITH ELECTRICAL FOR POWER AND DISCONNECT AS REQUIRED.
- 2. SMALL TANK TYPE, ELECTRIC WATER HEATER.

	EXPANSION TANK SCHEDULE															
						ACCEPT. VOL.	SYSTEM	FILL PRESS.	OPER. PRESS.	RELIEF PRESS.	MIN. TEMP.		SYSTEM		OPER. WT.	
TAG	#	MANUFACTURER	MODEL NUMBER	LOCATION	(GAL)	(GAL)	VOL. (GAL)	(PSIG)	(PSIG)	(PSIG)	(°F)	TEMP. (°F)	CONN. (IN)	H (IN)	(LBS)	NOTES
ET	1	WATTS	DETA-5	MECH ROOM	3.5	1.3	0	10	75	85	55	120	3/4"	10X14	30	1-3

NOTES

- 1. PROVIDE TANK RATED FOR ASME WORKING PRESSURE OF 125 PSIG.
- 2. PROVIDE TANK WITH VERTICAL CONFIGURATION.
- 3. ANCHOR TO HOUSEKEEPING PAD. COORDINATE WITH STRUCTURAL DESIGN.

	DOMESTIC RECIRCULATION PUMP SCHEDULE															
												ELECTRIC	CAL	EMERG		
						FLOW	HEAD (FT		CONNECTION SIZE	ON/OFF				POWER	OPER.	
TAG	#	MANUFACTURER	MODEL NUMBER	LOCATION	TYPE	(GPM)	WG)	RPM	(IN)	SETPOINT (°F)	HP	WATTS	VOLTS	PH (Y/N)	WT. (LBS)	NOTES
CP	1	BELL & GOSSETT	NBF-9U/LW	MECH ROOM	INLINE	5	6	2800	1/2"	90		41	115	1 No	10	1-4


NOTES

- 1. COORDINATE WITH ELECTRICAL FOR POWER AND DISCONNECT AS REQUIRED.
- 2. PUMP TO CONTAIN LESS THAN 0.25% LEAD CONTENT ON WETTED SURFACE FOR DOMESTIC DISTRIBUTION.
- 3. MAXIMUM WORKING PRESSURE 150 PSIG AND MAXIMUM OPERATING TEMPERATURE OF 225° F.
- 4. PROVIDE AQUASTAT TO OPERATE PUMP WHEN HOT WATER RETURN TEMPERATURE DROPS BELOW SETPOINT.

	PLUMBING FIXTURE SCHEDULE												
				ADA	FLOW		CONNEC	TION SIZ	ZE				
TAG	FIXTURE	MANUFACTURER	MODEL	(Y/N)	(GPF/GPM)	W	V	HW	CW	REMARKS			
FD-1	FLOOR DRAIN				0	4"							
FS-1	FLOOR SINK				0	4"							
OD-1	OVERFLOW DRAIN	JR SMITH			0	4"				SEE PLANS FOR SIZE			
RD-1	ROOF DRAIN	JR SMITH			0	6"				SEE PLANS FOS SIZE			
WC-1	WATER CLOSET WALL HUNG	KOHLER	KINGSTON LITE K-4330	N	1.28	4"	2"		1 1/4"	1.28 GALLONS PER FLUSH (GPF) SLOAN 111-1.28, OLSONITE NO.95 SEAT			
WC-2	WATER CLOSET WALL HUNG ADA	KOHLER	KINGSTON LITE K-4330	Υ	1.28	4"	2"		1 1/4"	1.28 GALLONS PER FLUSH (GPF) SLOAN 111-1.28, OLSONITE NO.95 SEAT			
UR-1	URINAL	KOHLER	K-4960-T BARDON LITE	N	0.5	2"	1 1/2"		3/4"	0.125 GALLONS PER FLUSH (GPF) SLOAN 186-0.125			
L-1	LAVATORY WALL HUNG ADA	KOHLER	BROOKELINE K-220204	Υ	0.5	1 1/2"	1 1/2"	1/2"	1/2"	0.5 GPM CHICAGO 2200			
MS-1	MOP SINK	STERN WILLIAMS	CRS-2200BP	N	2.5	3"	3"	3/4"	3/4"	CHICAGO 897-CRCF WITH VACUUM BREAKER			
S-1	SINK	ELKAY	DLR-2222-10	Y	1.5	2"	1 1/2"	1/2"	1/2"	CHICAGO 201-G8AE2805F317AB WITH GOOSNECK AND WRIST BLADE HANDLES, PROVIDE VALVE & SUPPLY TUBING FOR COFFEE MAKER			

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SCHEDULES

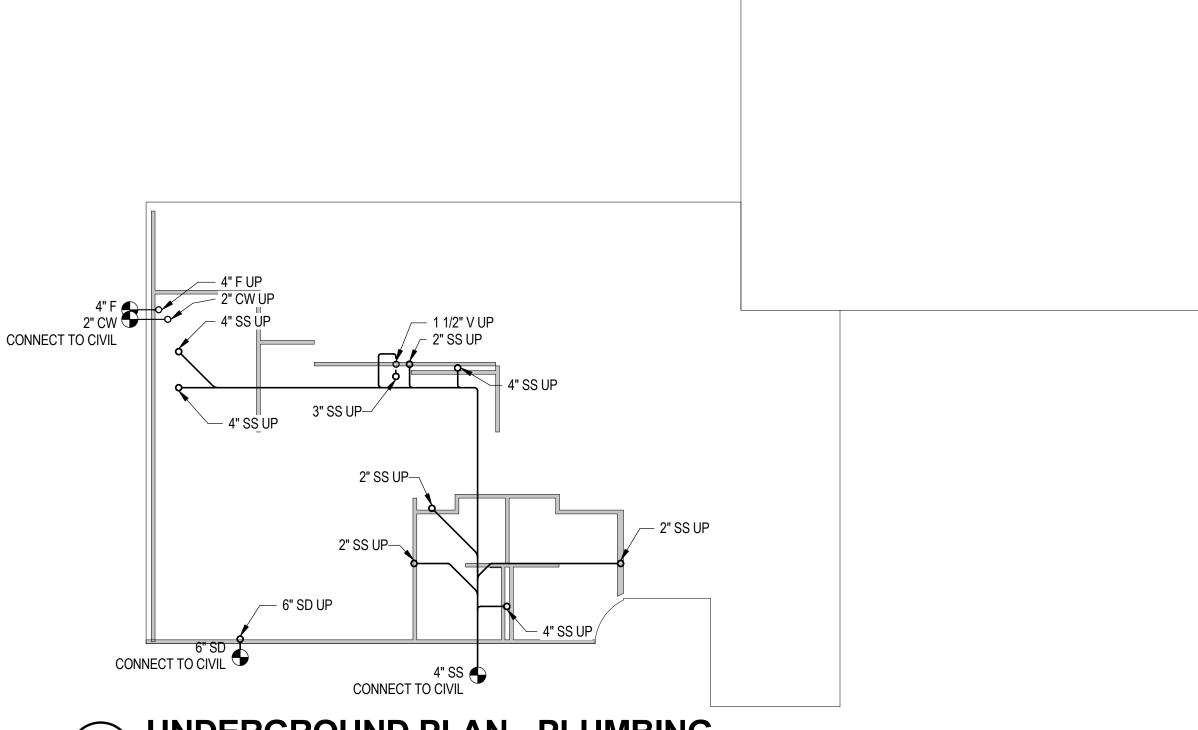


UNDERGROUND PLAN - PLUMBING

SCALE: 3/32" = 1'-0"

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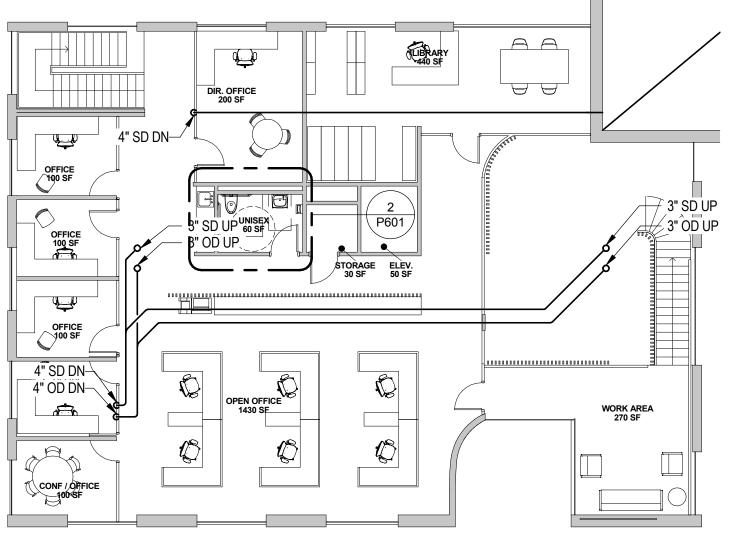


SCALE: 3/32" = 1'-0"

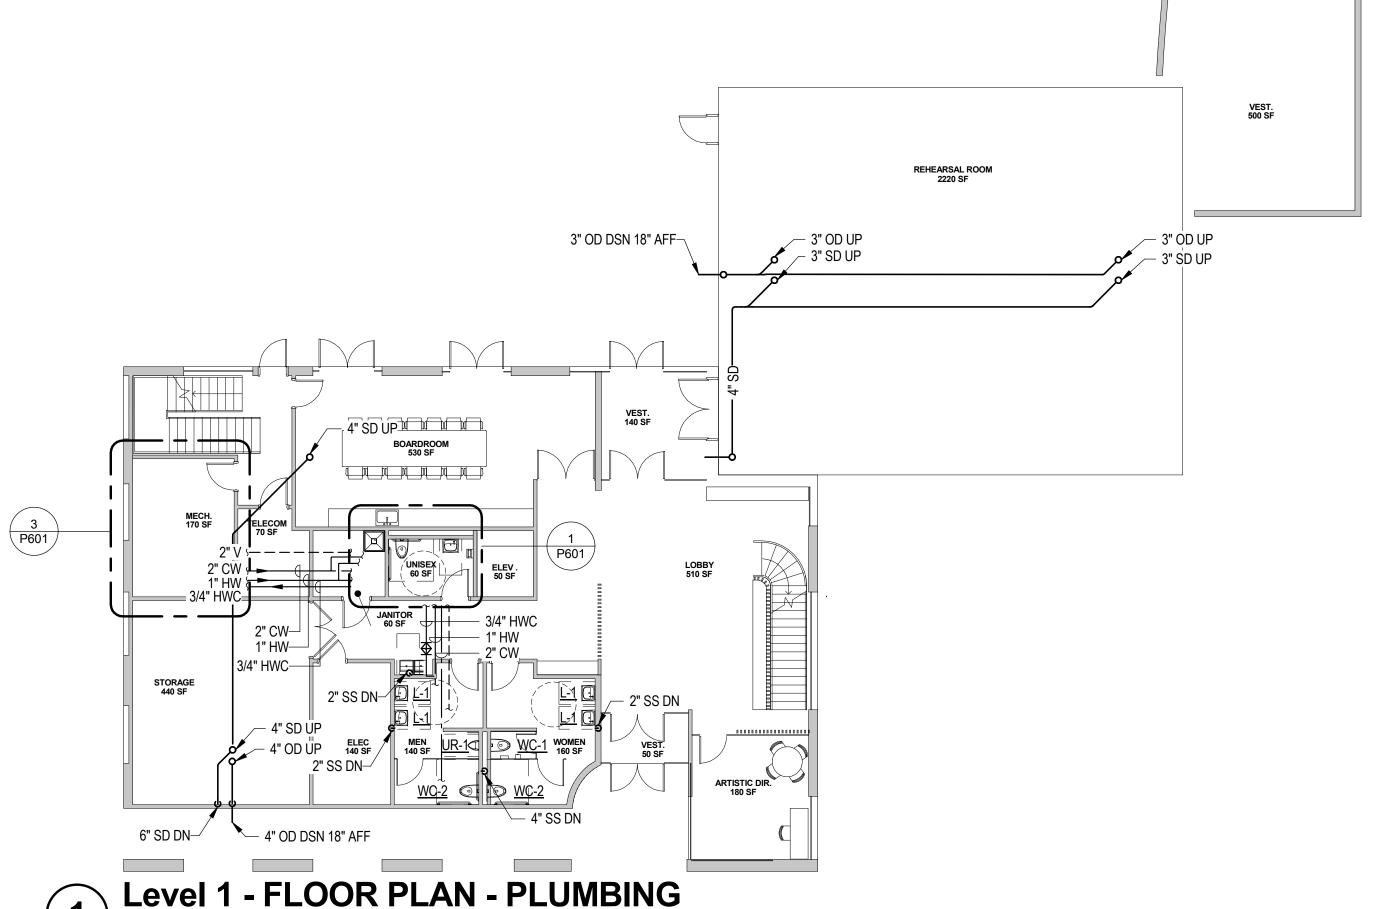UO OREGON BACH FESTIVAL

LEVEL 1 - FLOOR PLAN

HACKER



Level 2 - FLOOR PLAN - PLUMBING

SCALE: 3/32" = 1'-0"

UO OREGON BACH FESTIVAL


LEVEL 2 - FLOOR PLAN



Lower Roof - FLOOR PLAN - PLUMBING

SCALE: 3/32" = 1'-0"

UO OREGON BACH FESTIVAL

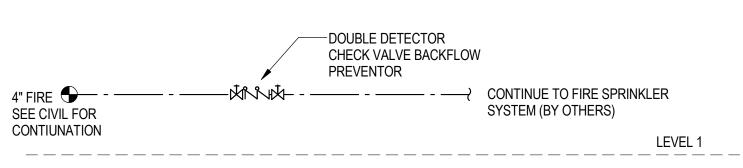

FIRE RISER DIAGRAM SCALE: NONE

DOUBLE CHECK VALVE BACK FLOW PREVENTOR—WATER METER

WATER METER

2° CW PRV
SEE CIVIL FOR CONTINNATION

BEWH

SEE DETAIL

PROF


LEVEL 2

LEVEL 2


LEVEL 2





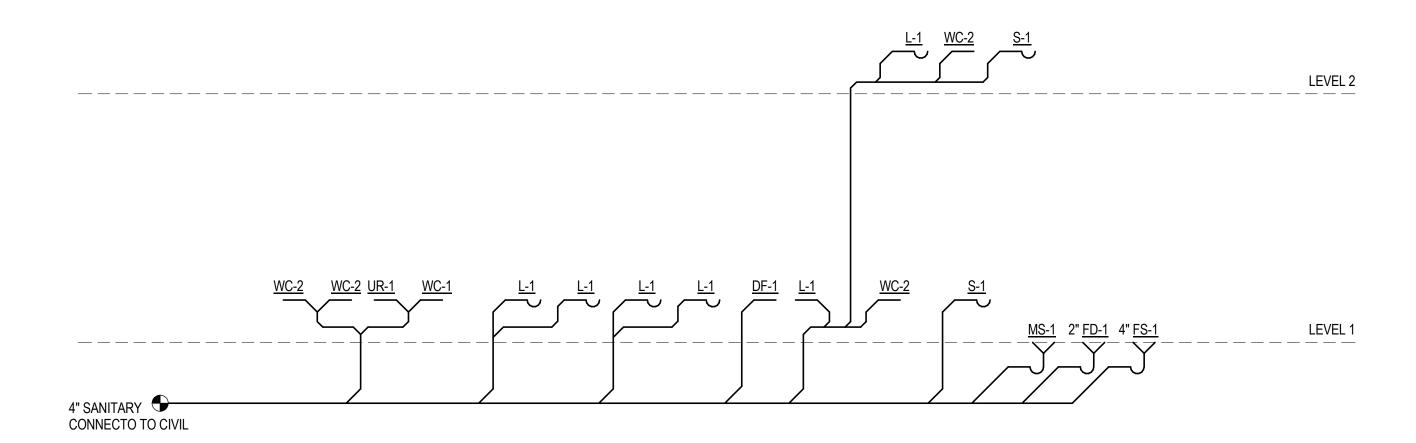


1 WASTE & VENT RISER DIAGRAM SCALE: NONE

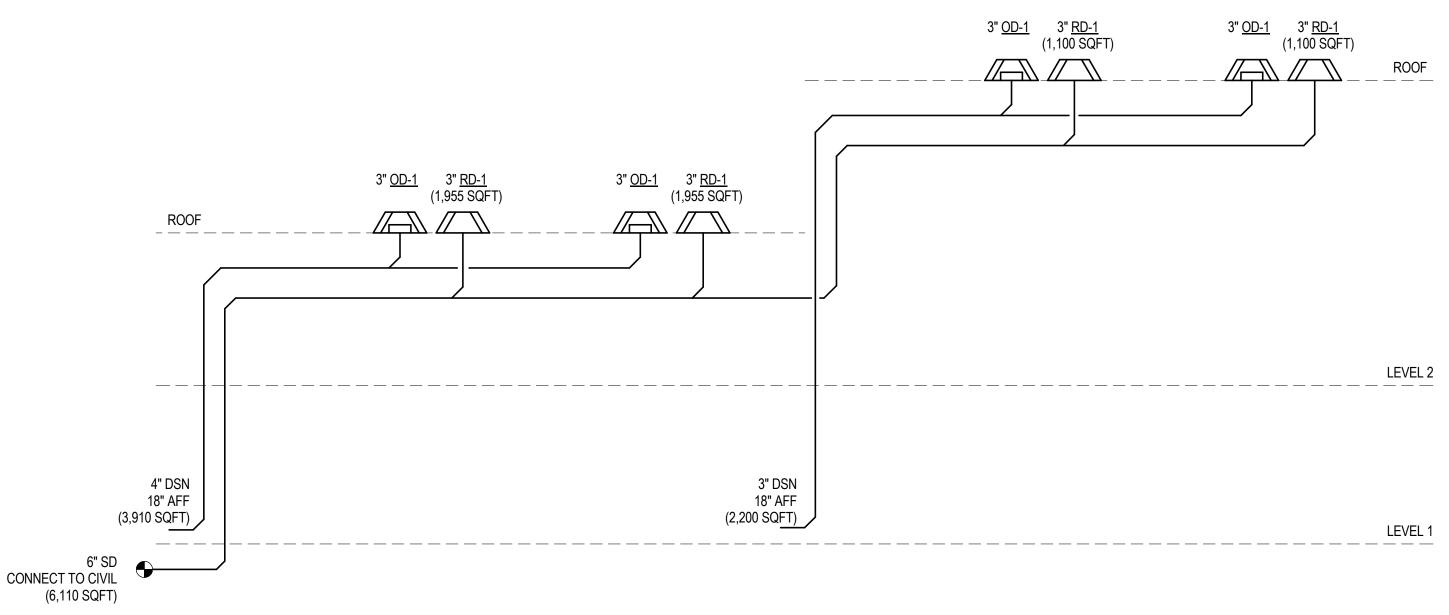




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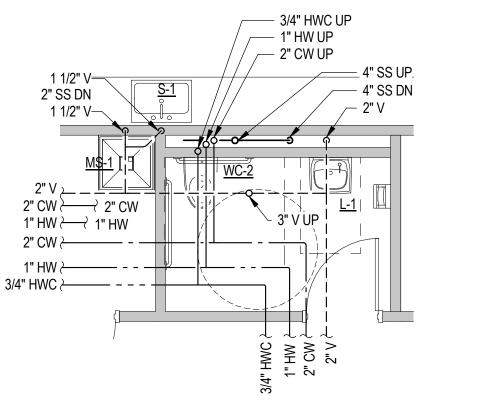
SCALE: 1/4" = 1'-0"

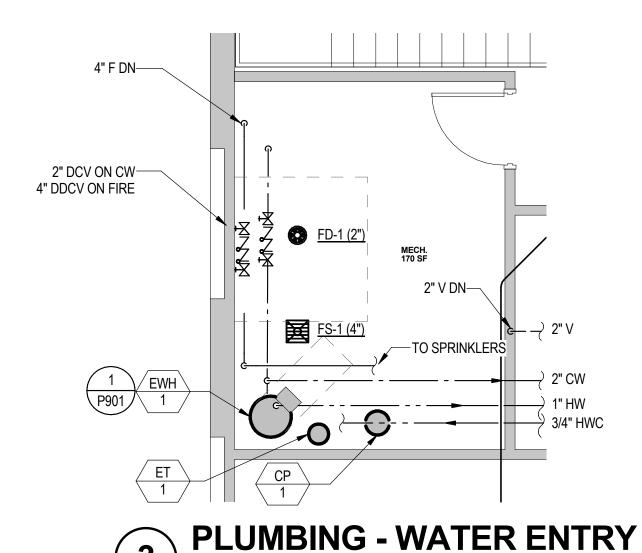




PLUMBING - LEVEL 2 RR

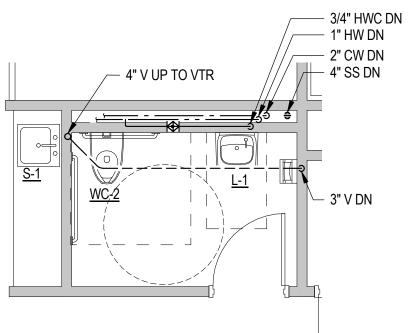SCALE: 1/4" = 1'-0"



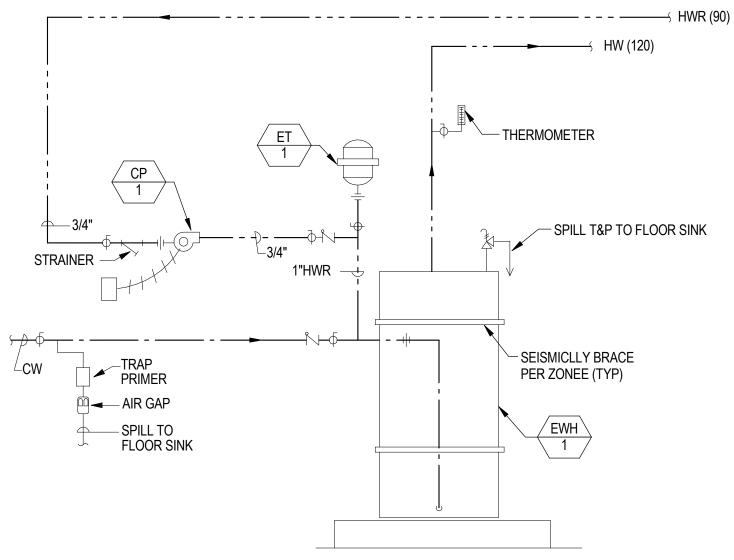

ELECTRIC WATER HEATER

SCALE: 1/8" = 1'-0"

UO OREGON BACH FESTIVAL

HACKER

PLUMBING DETAILS